

1405 HIGHLAND VIEW CT, LOS ALTOS, CA 94024

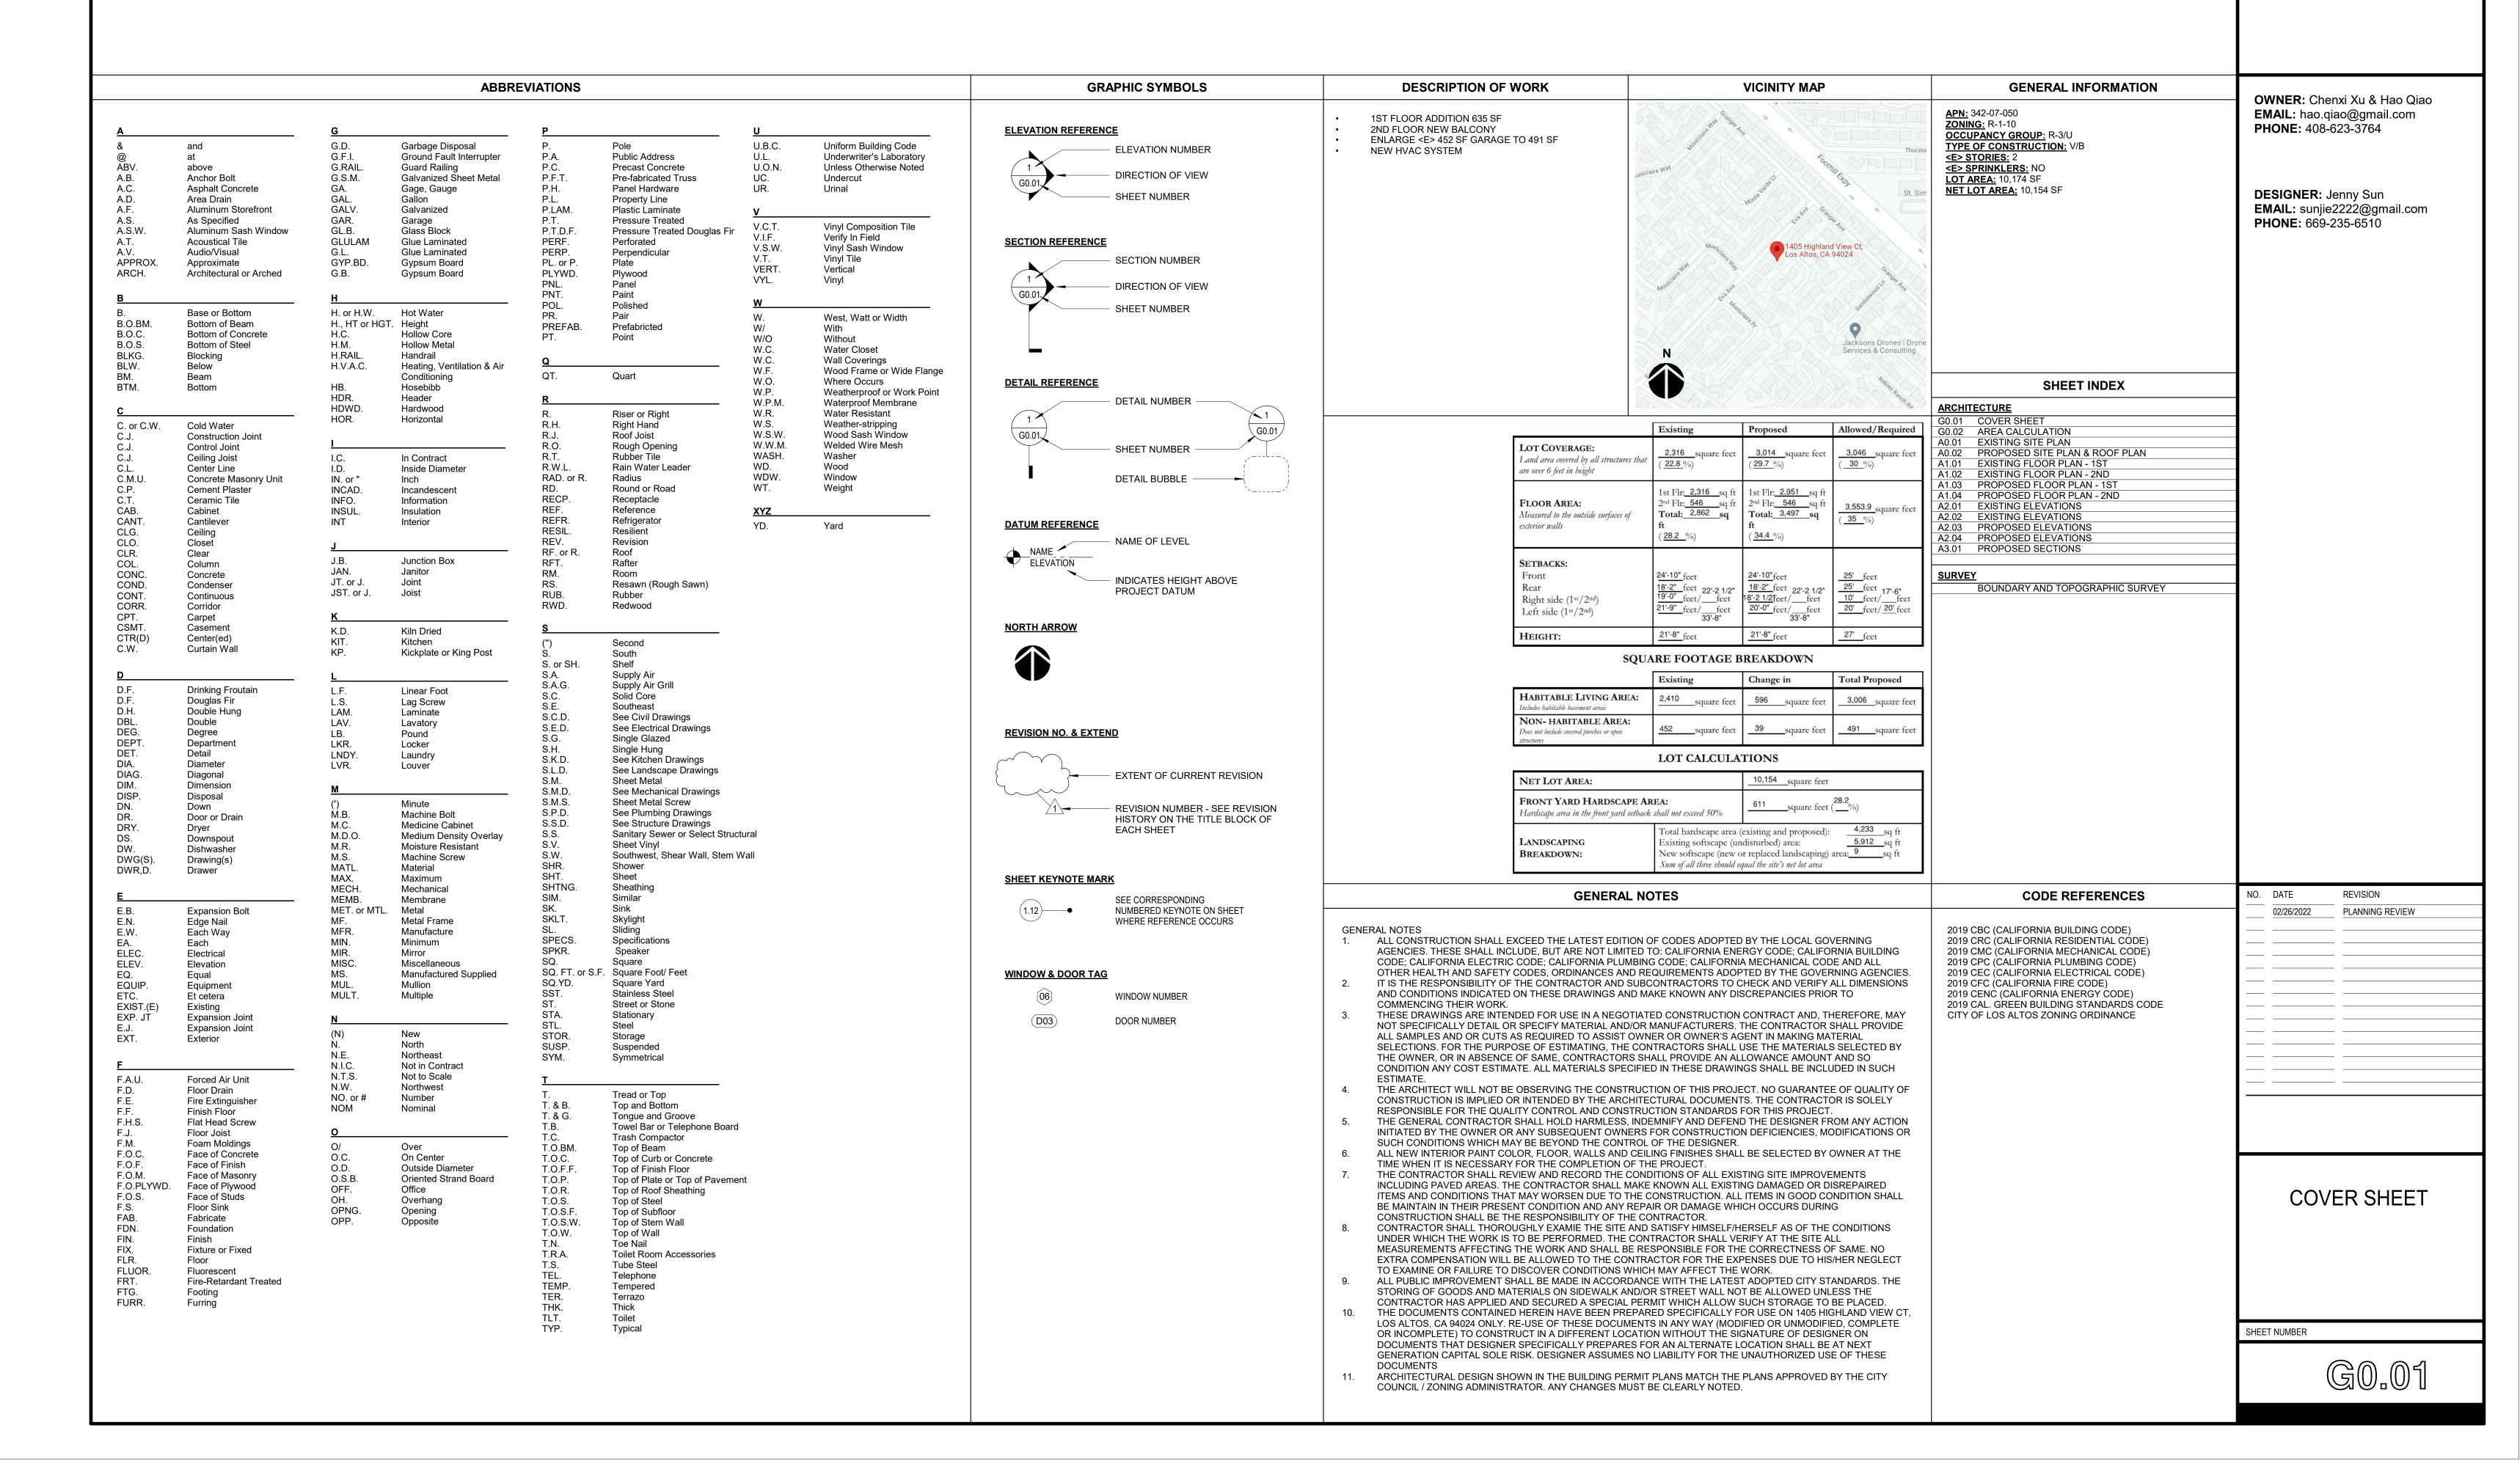

## BALCONY in the second of the

2 AREA CALCULATION - 2ND FLOOR 1/8" = 1'-0"

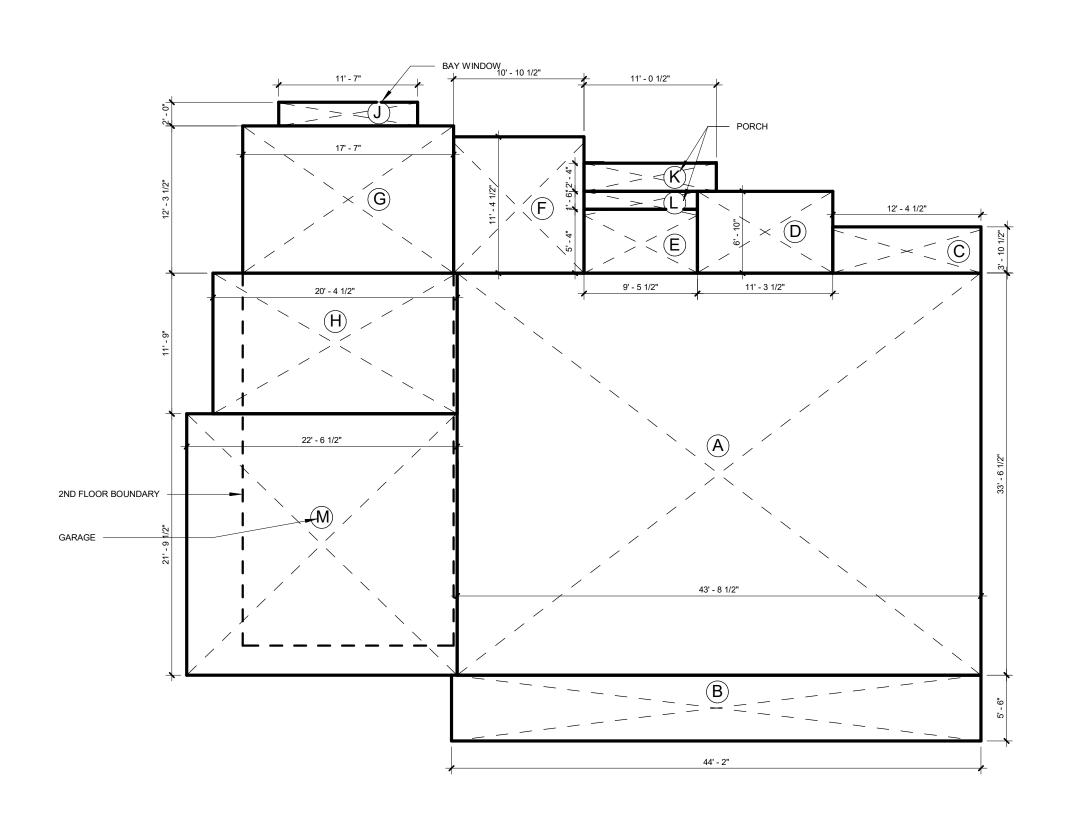

- A3' 8 1/2" X 33' 6 1/2" = 1464 sf
- B 44' 2" x 5' 6" = 242 sf
- C 12' 4 1/2" x 3' 10 1/2" = 48 sf
- D 11' 3 1/2" x 6' 10" = 77 sf
- 9' 5 1/2" X 5' 4" = 50 sf
- F 10' 10 1/2" x 11' 4 1/2" = 124 sf
- G 17' 7" x 12' 3 1/2" = 216 sf
- H 20' 4 1/2" X 11' 9" = 239 sf
- 17' 7" X 31' 1" = 546 sf (2ND FLOOR)

  (M) 22' 6 1/2" X 21' 9 1/2" = 491 sf (GARAGE)
- TAL FLOOR AREA:
- 11' 7" X 2' 0" = 23 sf (BAY WINDOW)
- (K) 11' 1/2" X 2' 4" = 26 sf (PORCH)
- 9' 5 1/2" X 1' 6" = 14 sf (PORCH)

TOTAL LOT COVERAGE:

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D. DATE REVISION


02/26/2022 PLANNING REVIEW

AREA CALCULATION

SHEET NUMBER

G0.02

1 1ST FLOOR PLAN - PROPOSED 1/8" = 1'-0"

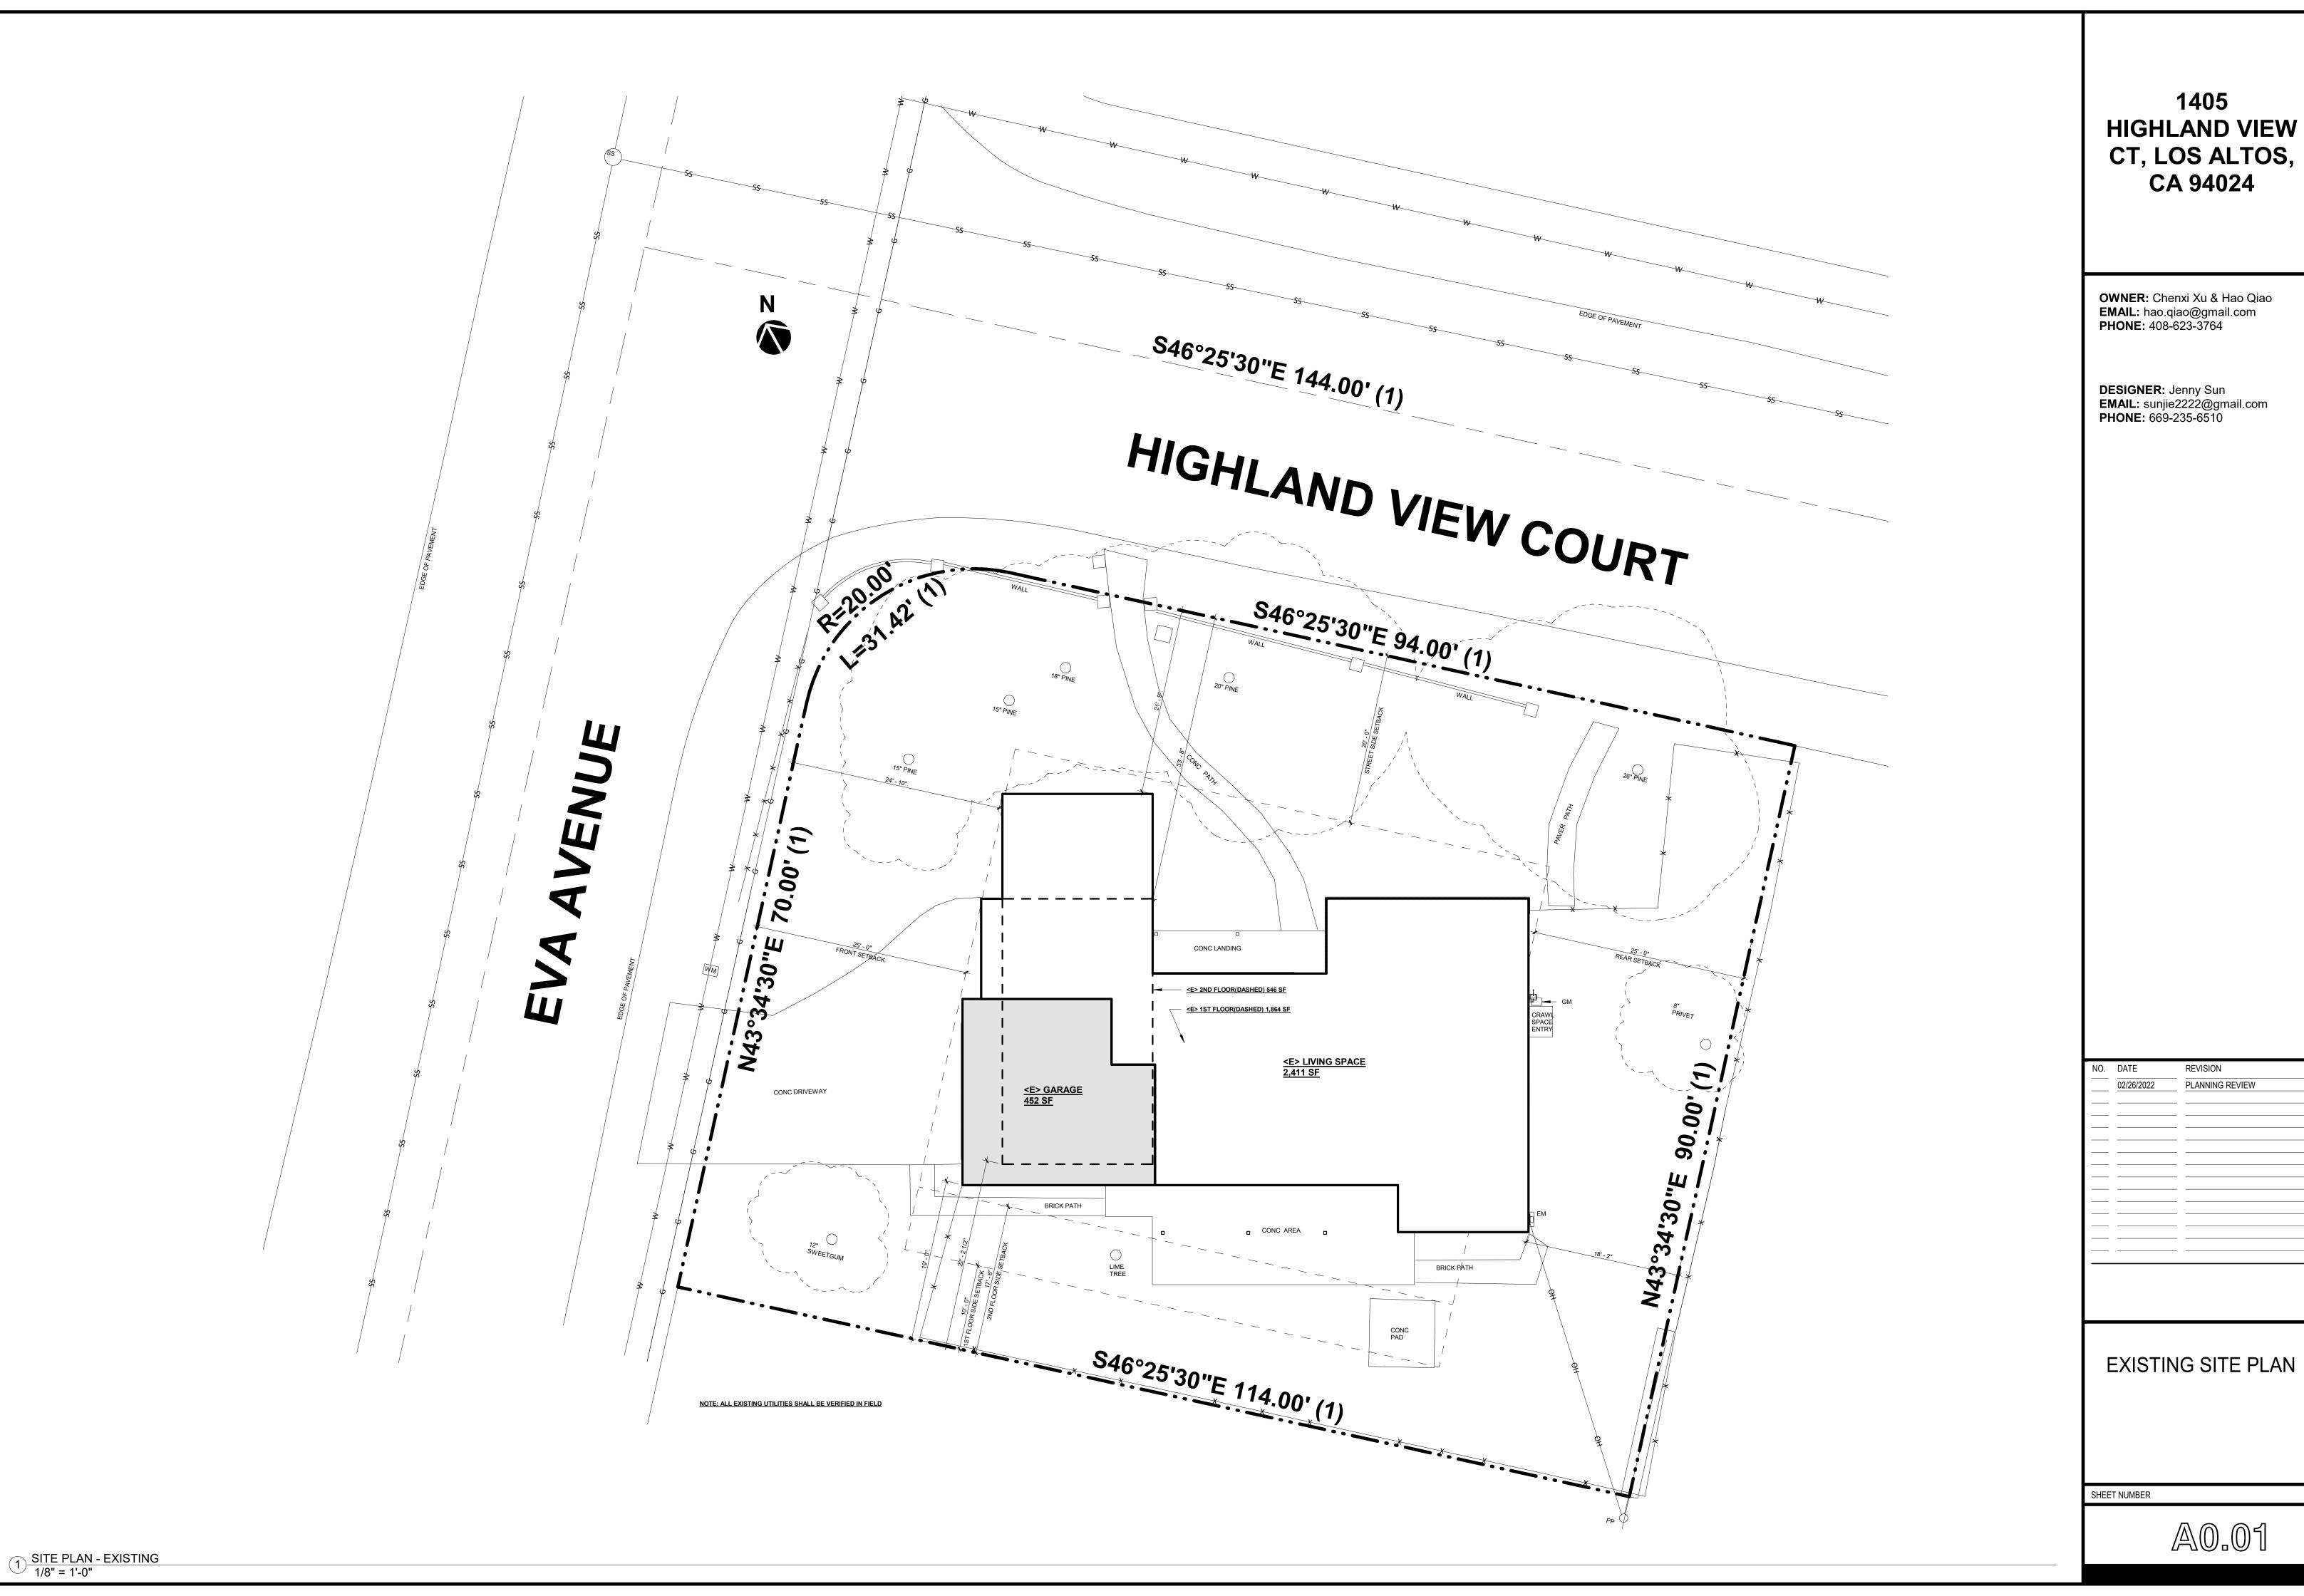

## SITE PLAN & ROOF PLAN NOTES:

- THE CONTRACTOR SHALL VERIFY ON SITE ALL GRADES, EXISTING IMPROVEMENTS, PROPERTY LINES, EASEMENTS, SETBACKS, UTILITIES, AND SUB-STRUCTURES. WHERE DISCREPANCIES OCCUR, CONTACT ARCHITECT.
- OCCUR, CONTACT ARCHITECT.

  ALL EXISTING UTILITIES SHALL BE VERIFIED IN FIELD
  GRADE SITE MIN. 5% SLOPE (2% IS PERMITTED AT IMPERVIOUS SURFACES) FOR AT LEAST 10'
  AWAY FROM BUILDING PERIMETER AND ADJACENT PROPERTY LINES, TYP. IN NO CASE
  SHALLGRADING INCREASE SHEET FLOW TO ADJOINING PROPERTIES. ENTIRE SITE SHALL DRAIN
  TOWARD PUBLIC STREET. CRC801.3.
  PRIOR TO FOUNDATION INSPECTION BY THE CITY, THE LLS OF RECORD SHALL PROVIDE A
  WRITTEN CERTIFICATION THAT ALL BUILDING SETBACKS ARE PER THE APPROVED PLANS.
  DISPOSITION AND TREATMENT OF STORM WATER WILL COMPLY WITH THE NATIONAL POLLUTION
  DISCHARGE ELIMINATION SYSTEM ("NPDES") STANDARDS AND IMPLEMENTATION STANDARDS
  ESTABLISHED BY THE SANTA CLARA VALLEY URBAN RUNOFF POLLUTION PREVENTION PROGRAM.
  ALL PLUMBING VENTS SHALL BE COMBINED INTO A MINIMUM AMOUNT OF ROOF PENETRATIONS.
  LIRNIGATION SYSTEM SHALL BE DESIGNED TO PREVENT SATURATION OF SOIL ADJACENT TO

- IRRIGATION SYSTEM SHALL BE DESIGNED TO PREVENT SATURATION OF SOIL ADJACENT TO
- BUILDING.
  ATTIC VENTILATION SHALL BE PROVIDED PER 2019 CRC SECTION R806.2 (ALSO SEE CALCULATIONS.)
  THE MINIMUM NET FREE VENTILATING AREA SHALL BE 1/150 OF THE AREA OF THE VENTED SPACE. THE MINIMUM NET FREE VENTILATION AREA SHALL BE 1/300 OF THE VENTED SPACE PROVIDED AT LEAST 40 PERCENT AND NOT MORE THAN 50 PERCENT OF THE REQUIRED VENTILATING AREA IS PROVIDED BY VENTILATORS LOCATED IN THE UPPER PORTION OF THE ATTIC OR RAFTER SPACE.
- PROVIDED BY VENTILATORS LOCATED IN THE UPPER PORTION OF THE ATTIC OR RAFTER SPACE.

  UPPER VENTILATORS SHALL BE LOCATED NO MORE THAN 3 FEET BELOW THE RIDGE OR HIGHEST POINT OF THE SPACE PER 2019 CRC R806.2.

  OVERHANG DIMENSIONS SHALL BE AS NOTED ON ROOF PLAN.

  CLASS A ROOF COVERING SHALL BE AS SPECIFIED PER ELEVATION STYLE & INSTALLED PER.

  MNFR. SPEC'S. R905.2.2. ASPHALT SHINGLES SHALL BE USED ONLY ON ROOF SLOPES OF 2: 12 OR GREATER. FOR ROOF SLOPES FROM 2:12 UP TO 4: 12, DOUBLE UNDERLAYMENT APPLICATION IS
- REQUIRED IN ACCORDANCE WITH SECTION R905.1.1.
  ALL NEW ROOF DRAINAGE WILL BE DIRECTED TO LANDSCAPED.


- SITE MANAGEMENT DURING CONSTRUCTION:

  1. CONSTRUCTION SITE SHALL BE ENCLOSED BY 6' OPAQUE FENCE AT ALL TIMES DURING
- CONSTRUCTION SITE SHALL BE ENCLOSED 5.7 G. A.G. CONSTRUCTION.

  NO CONSTRUCTION MATERIAL, EQUIPMENT, PORTABLE TOILETS, TRASH CONTAINERS, OR DEBRIS SHALL BE PLACED IN THE PUBLIC RIGHT-OF-WAY.


  A TRASH CONTAINER SHALL BE MAINTAINED ON SITE AT ALL TIMES AND DEBRIS ON SITE WHICH COULD OTHERWISE BLOW AWAY, SHALL BE REGULARLY COLLECTED AND PLACED
- WHICH COULD OTHERWISE BLOW AWAY, SHALL BE REGULARLY COLLECTED AND PLACED IN CONTAINER.

  ALL CONSTRUCTION DEBRIS (WOOD SCRAPS AND OTHER DEBRIS, WHICH CANNOT BLOW AWAY) SHALL BE PILED WITHIN THE PROPERTY LINES OF THE PROJECT IN A NEAT AND
- SAFE MANNER. THE PROJECT SHALL HAVE A SIGNAGE VIEWABLE FROM THE PUBLIC STREET THAT INDICATES THE HOURS OF CONSTRUCTION AS: MON- FRI FROM 7:30 AM TO 6 PM, SATURDAYS FROM 9AM TO 5 PM.

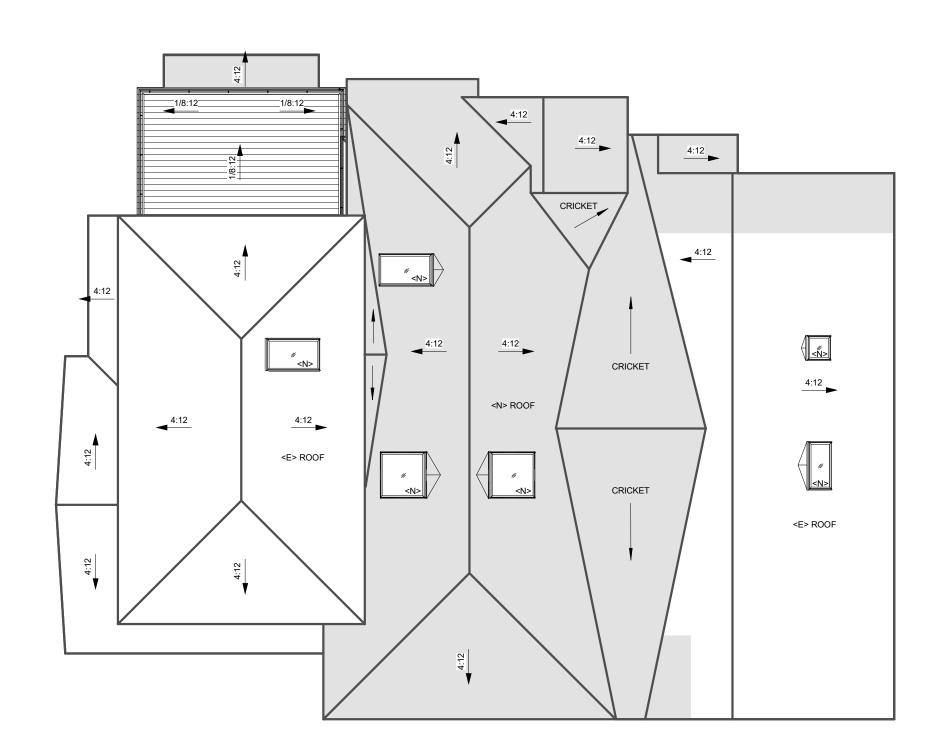

1) SITE PLAN - PROPOSED 1/8" = 1'-0"

2 ROOF PLAN - PROPOSED 1/8" = 1'-0"

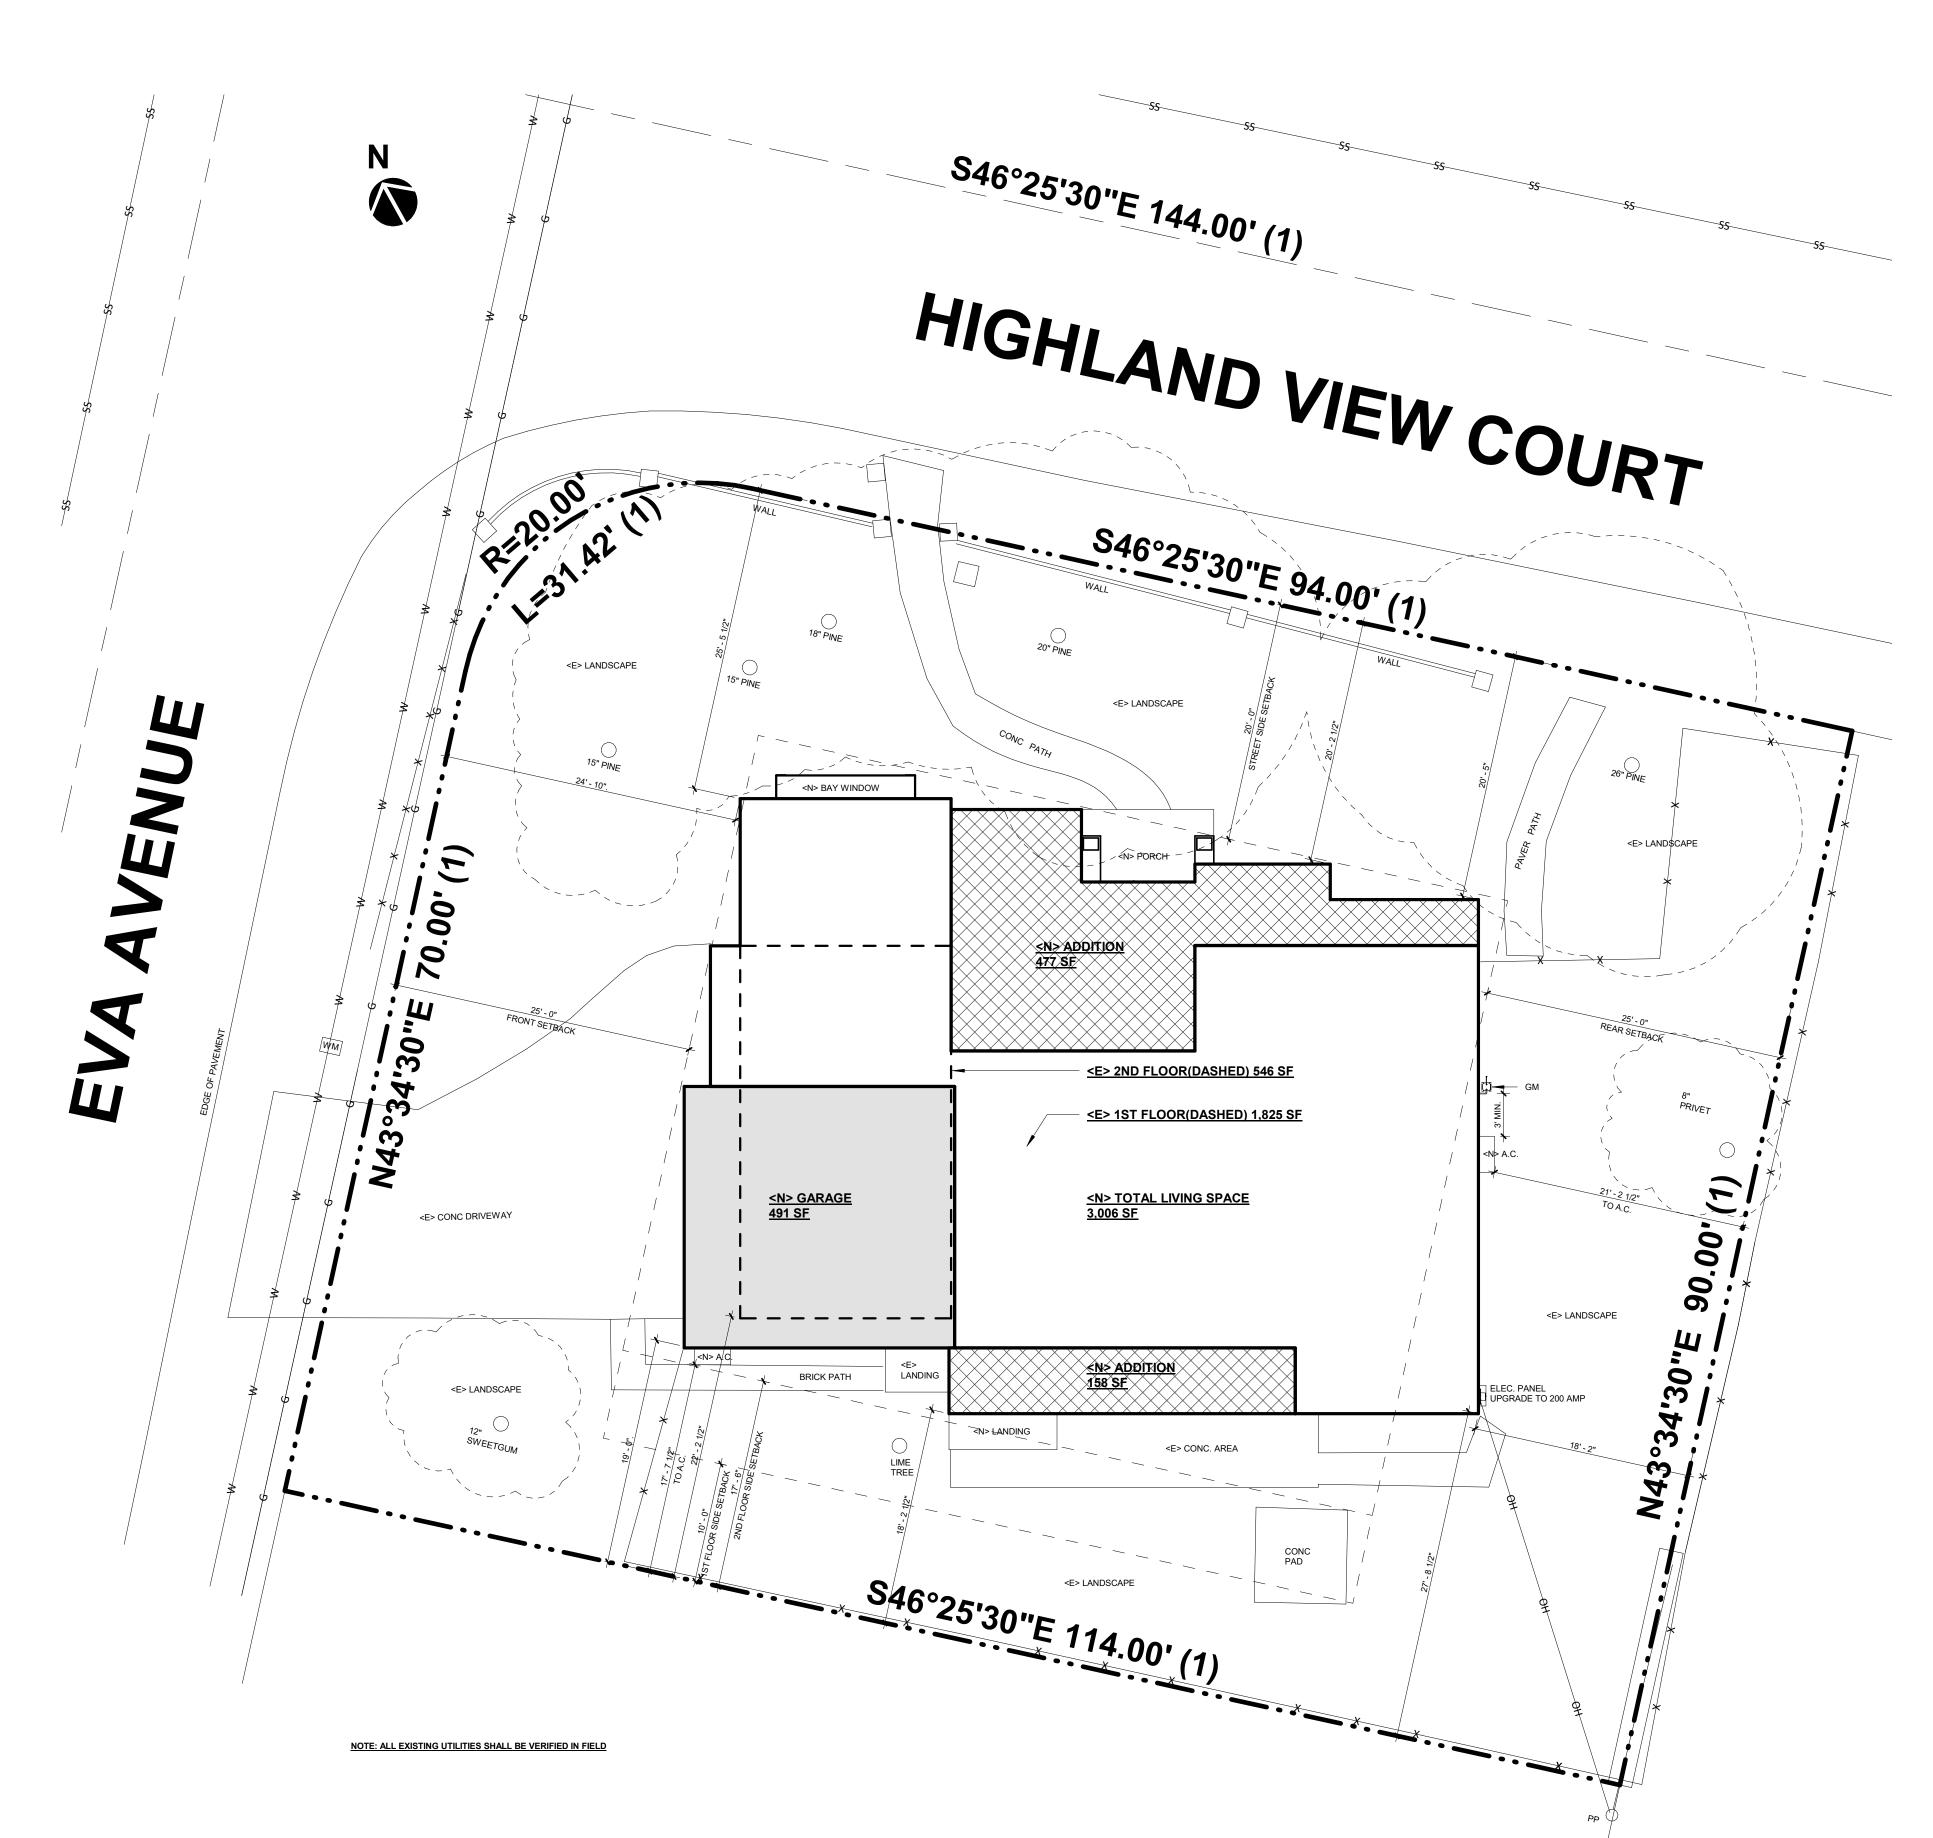

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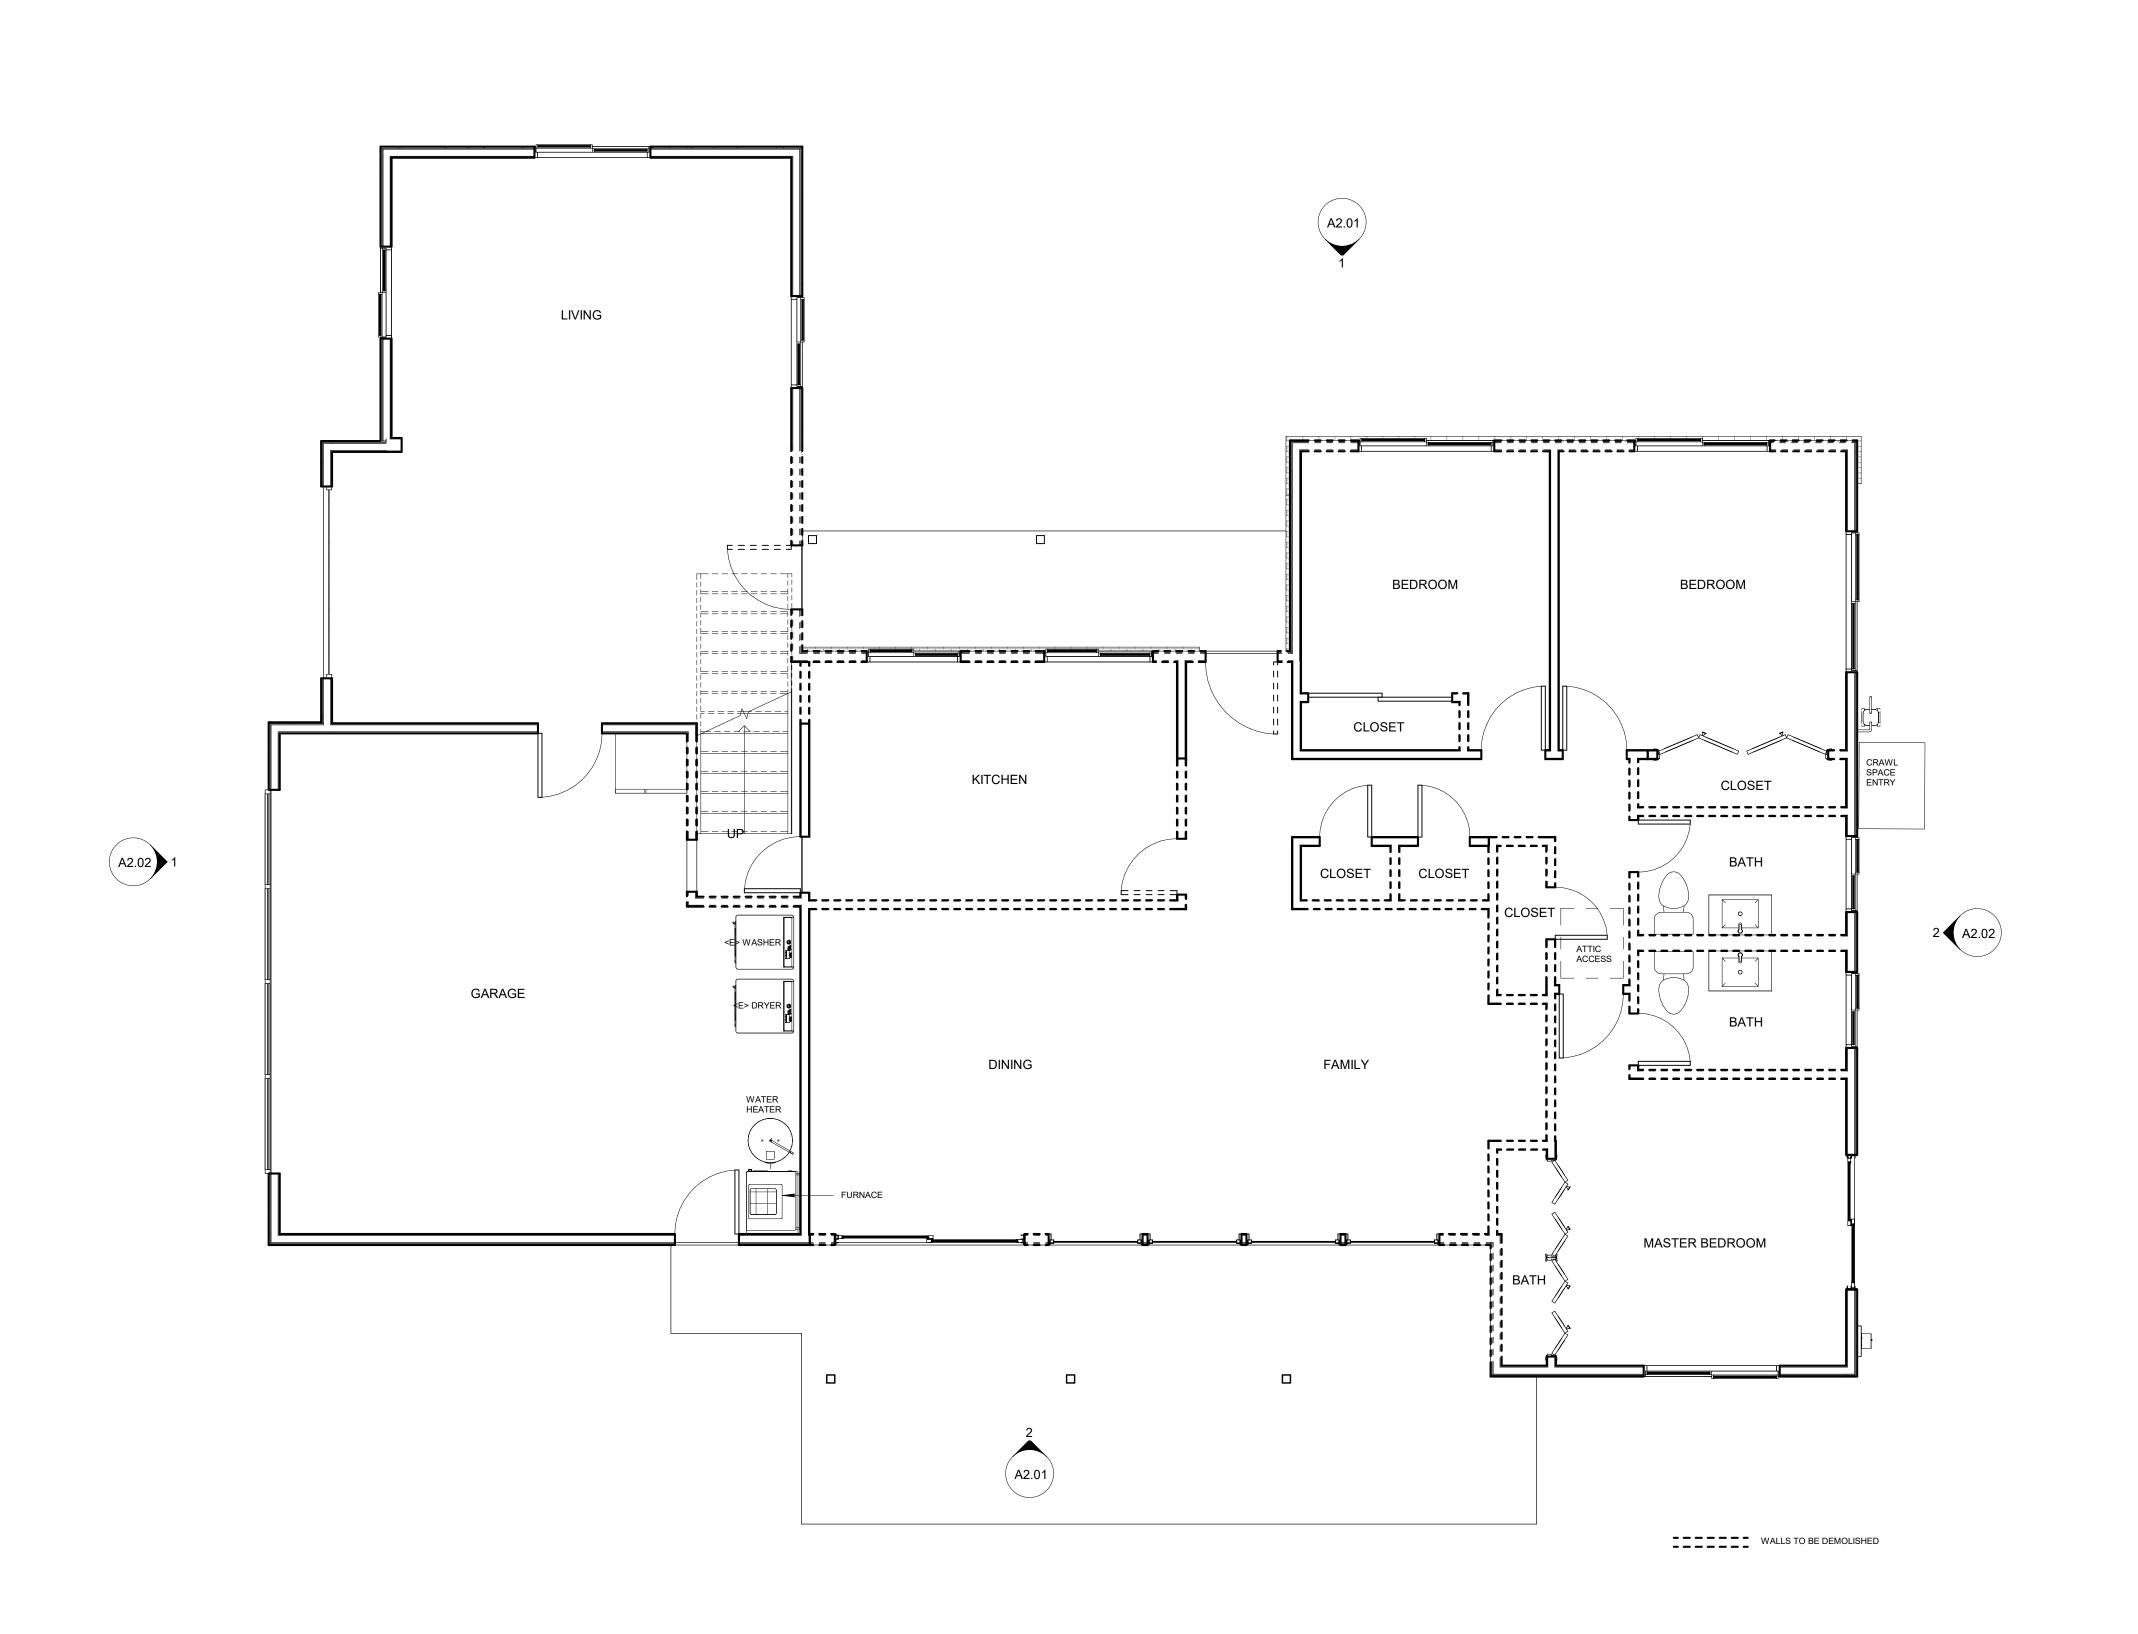
OWNER: Chenxi Xu & Hao Qiao EMAIL: hao.qiao@gmail.com **PHONE**: 408-623-3764

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PROPOSED SITE PLAN & ROOF PLAN

SHEET NUMBER



1ST FLOOR PLAN - EXISTING 1/4" = 1'-0" 1405 HIGHLAND VIEW CT, LOS ALTOS, CA 94024

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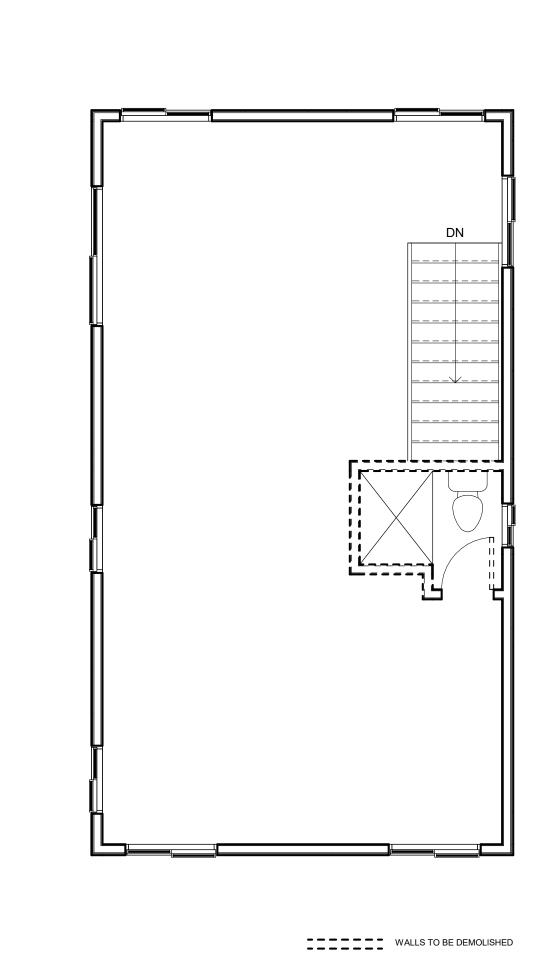
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DATE REVISION

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EXISTING FLOOR PLAN - 1ST

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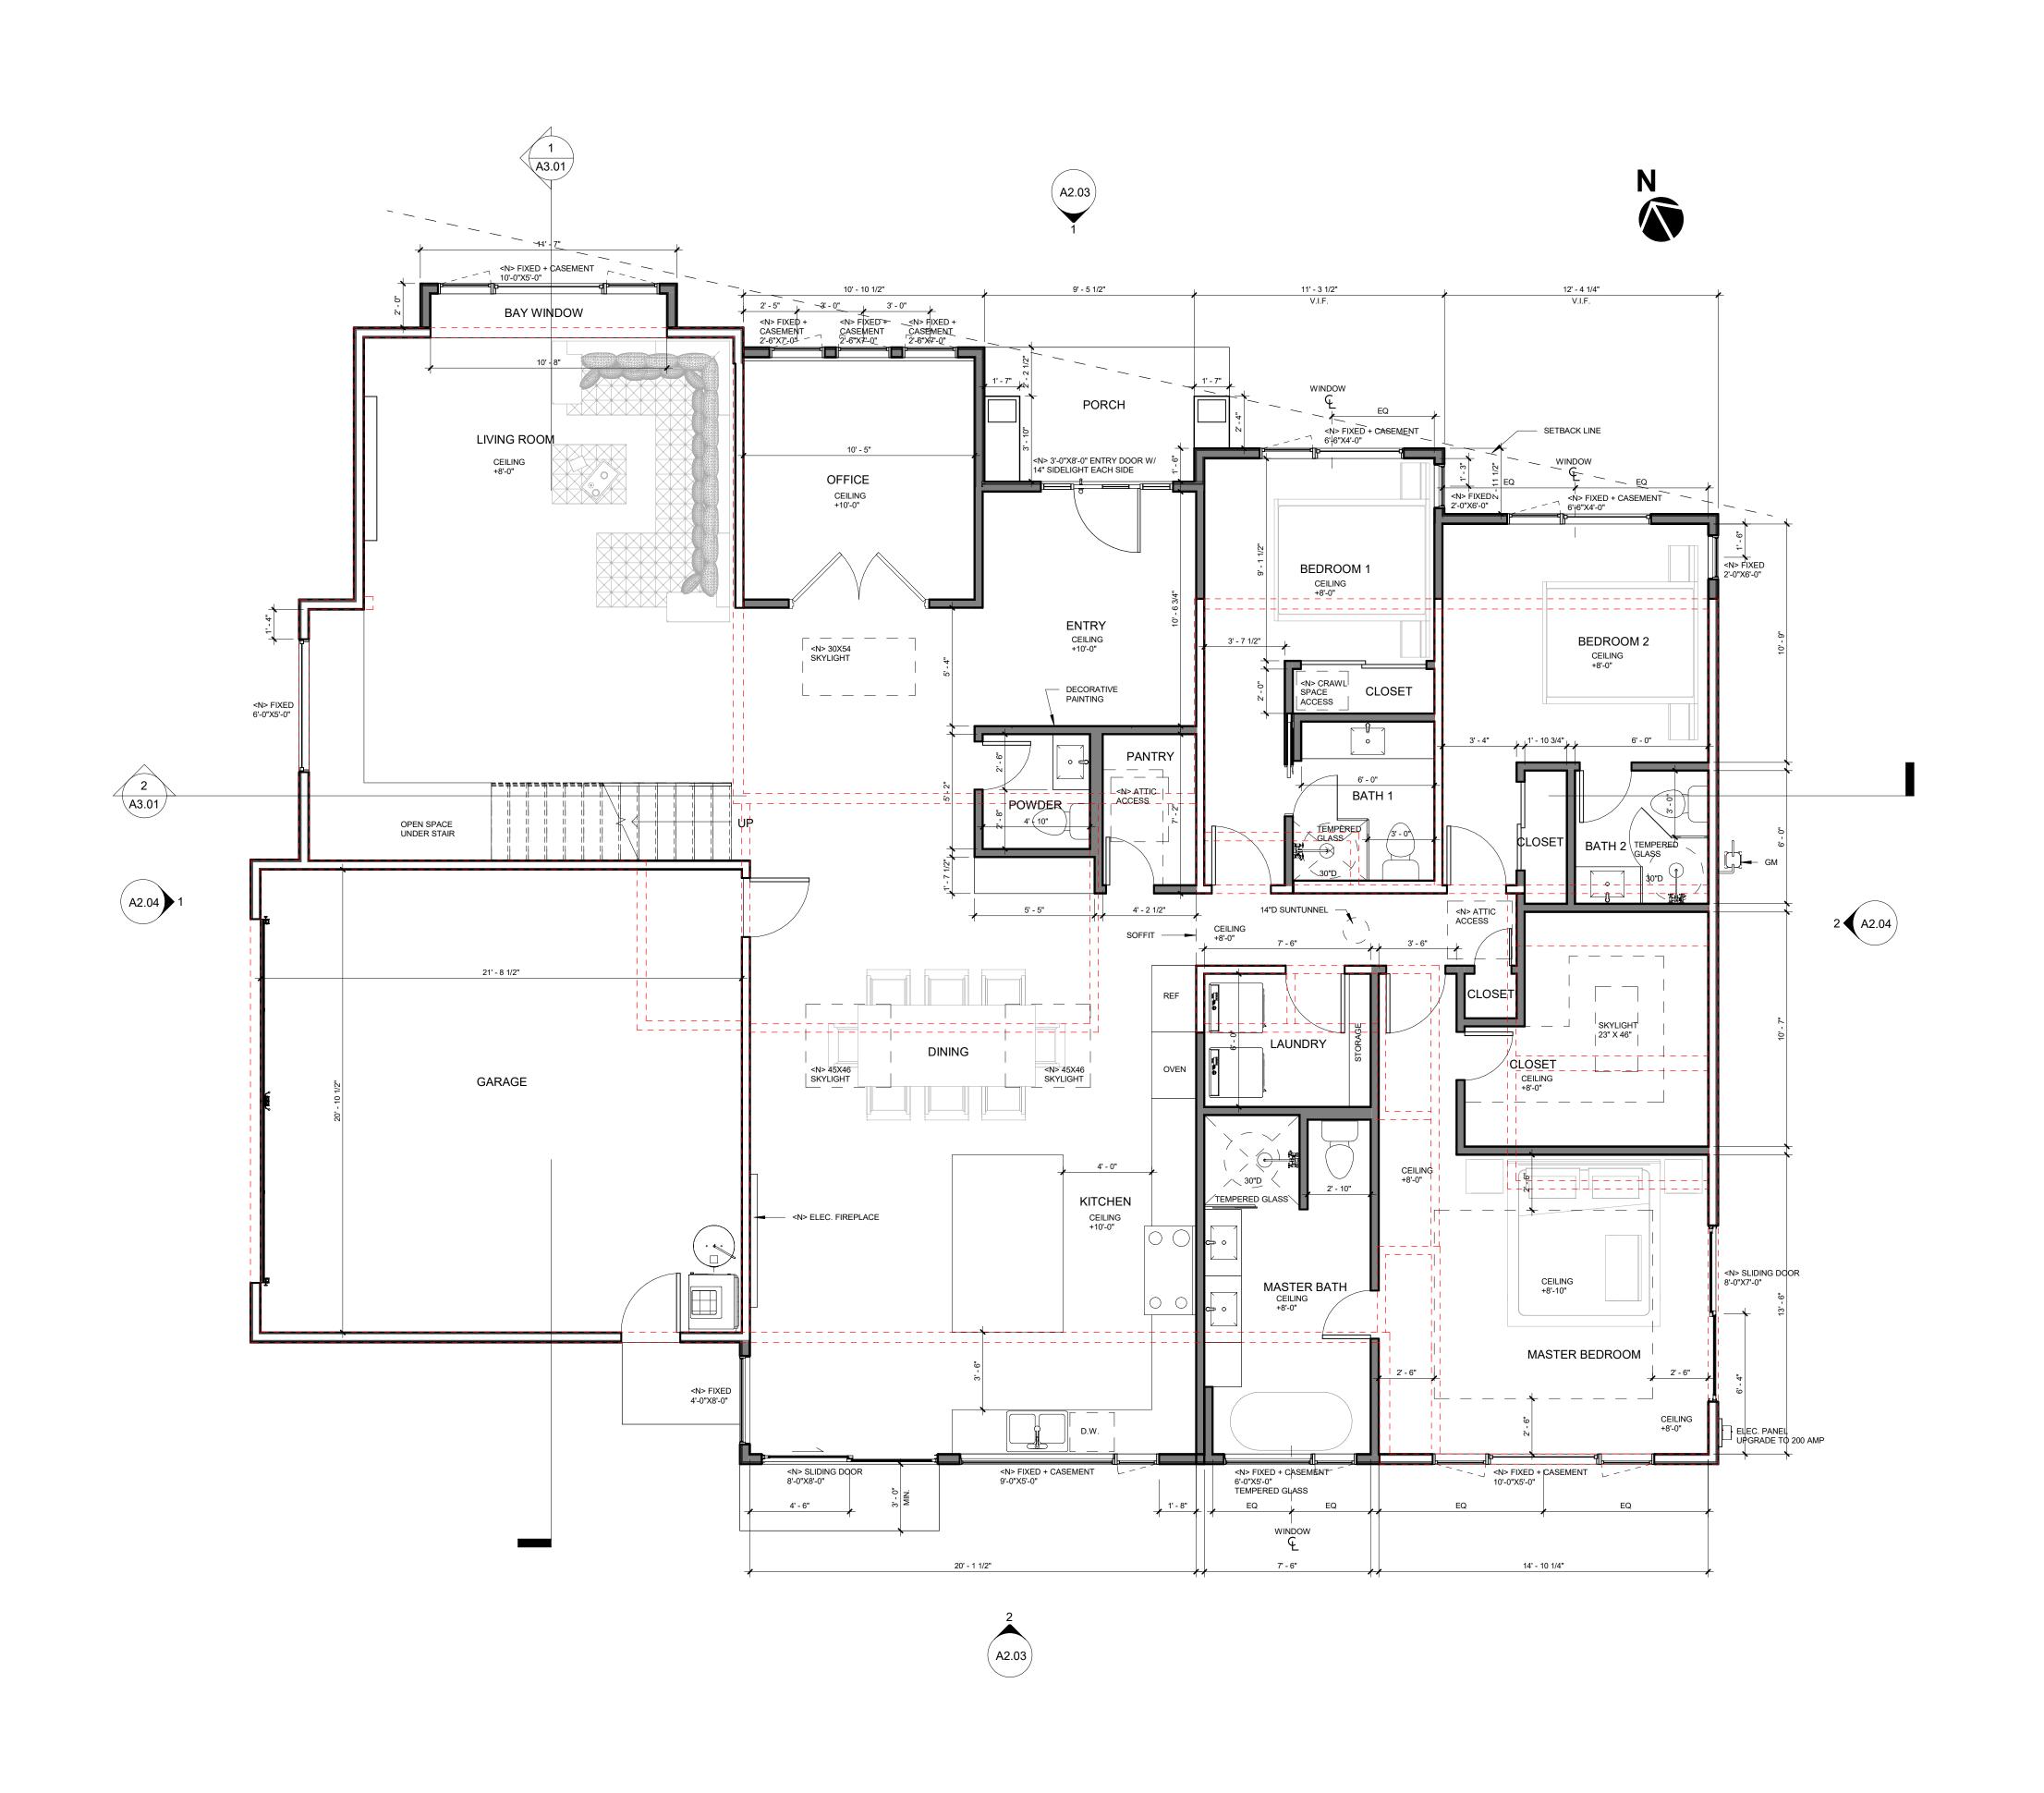
**DESIGNER:** Jenny Sun **EMAIL:** sunjie2222@gmail.com **PHONE:** 669-235-6510

NO. DATE REVISION

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EXISTING FLOOR PLAN - 2ND

SHEET NUMBER



OWNER: Chenxi Xu & Hao Qiao EMAIL: hao.qiao@gmail.com PHONE: 408-623-3764


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DATE REVISION

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PROPOSED FLOOR PLAN - 1ST

SHEET NUMBER



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PROPOSED FLOOR PLAN - 2ND

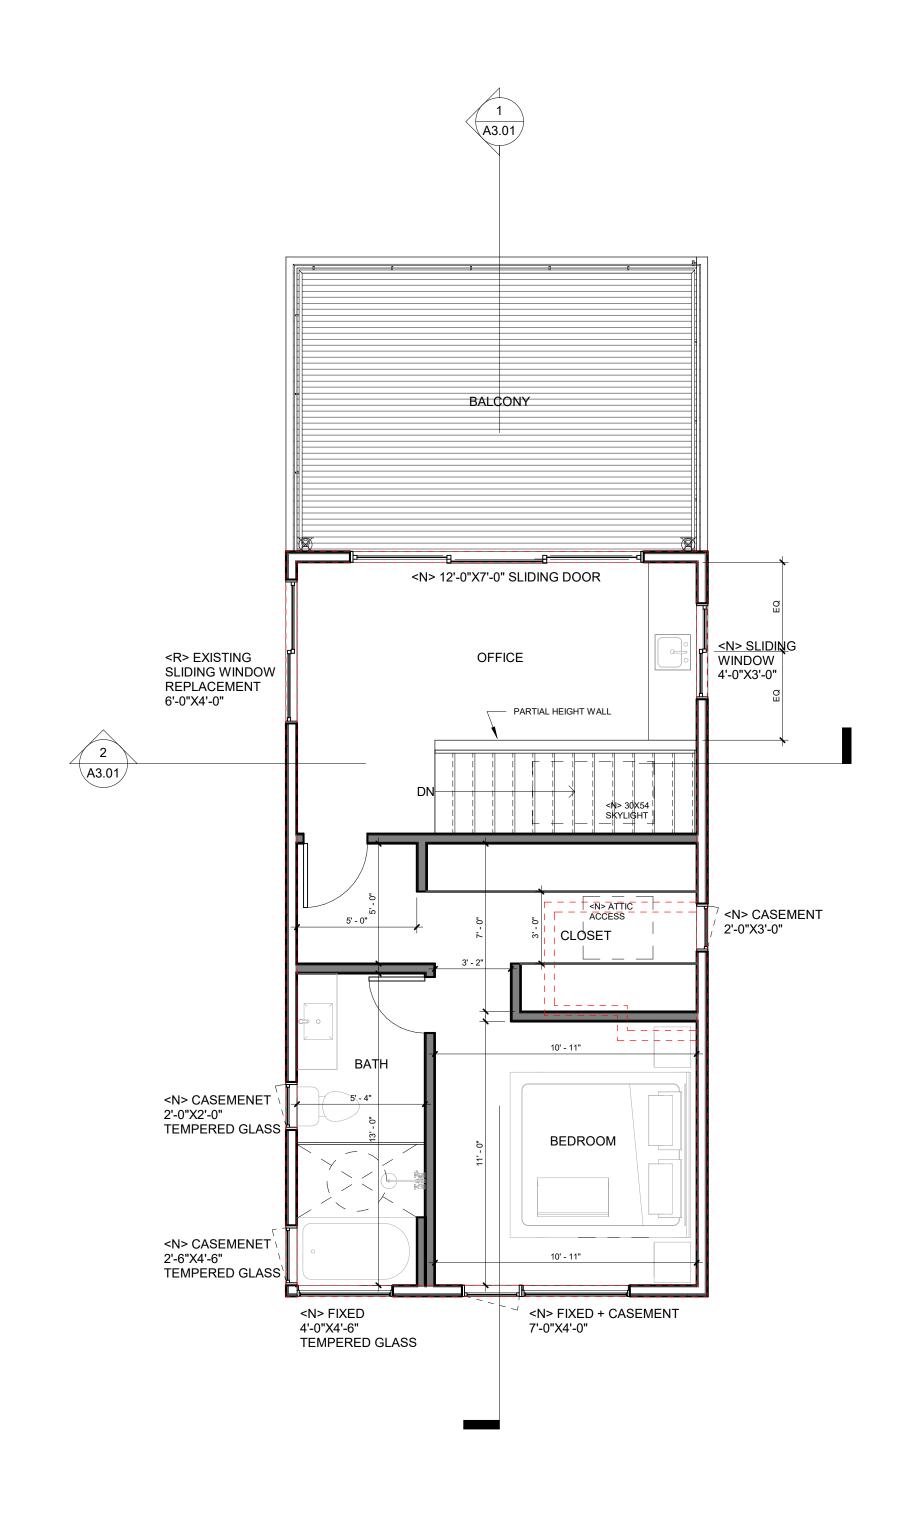SHEET NUMBER








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PROPOSED ELEVATIONS


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A2.03



2 SOUTH ELEVATION - PROPOSED 1/4" = 1'-0"



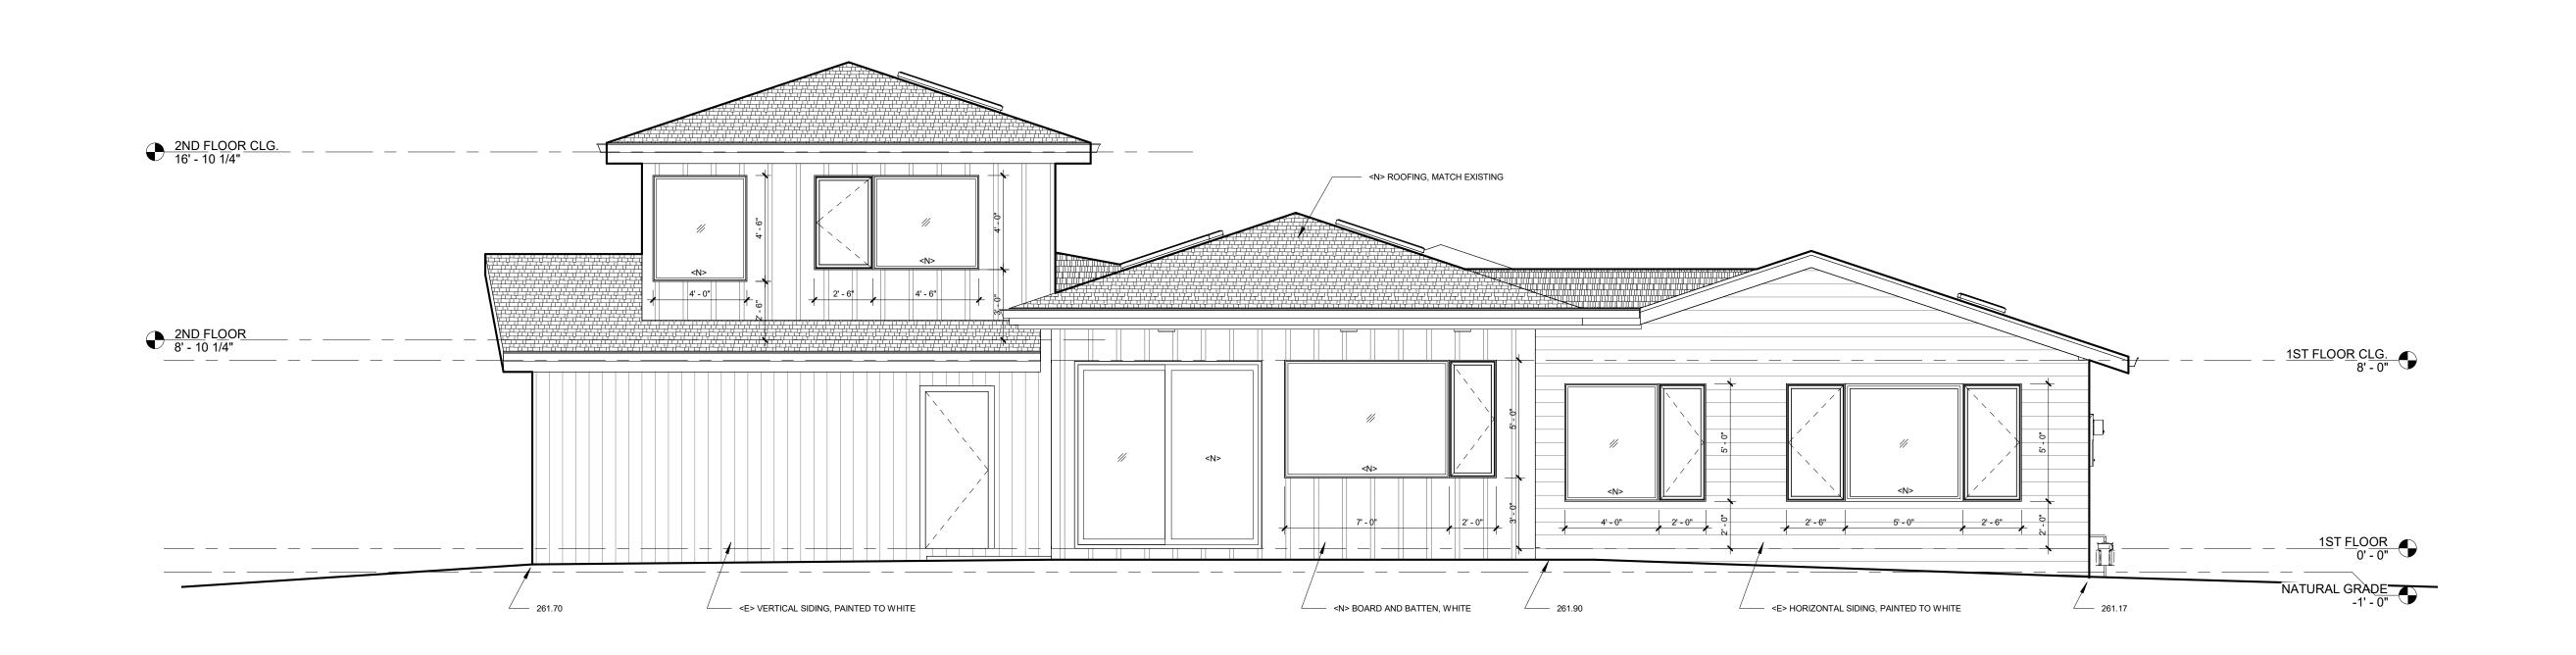

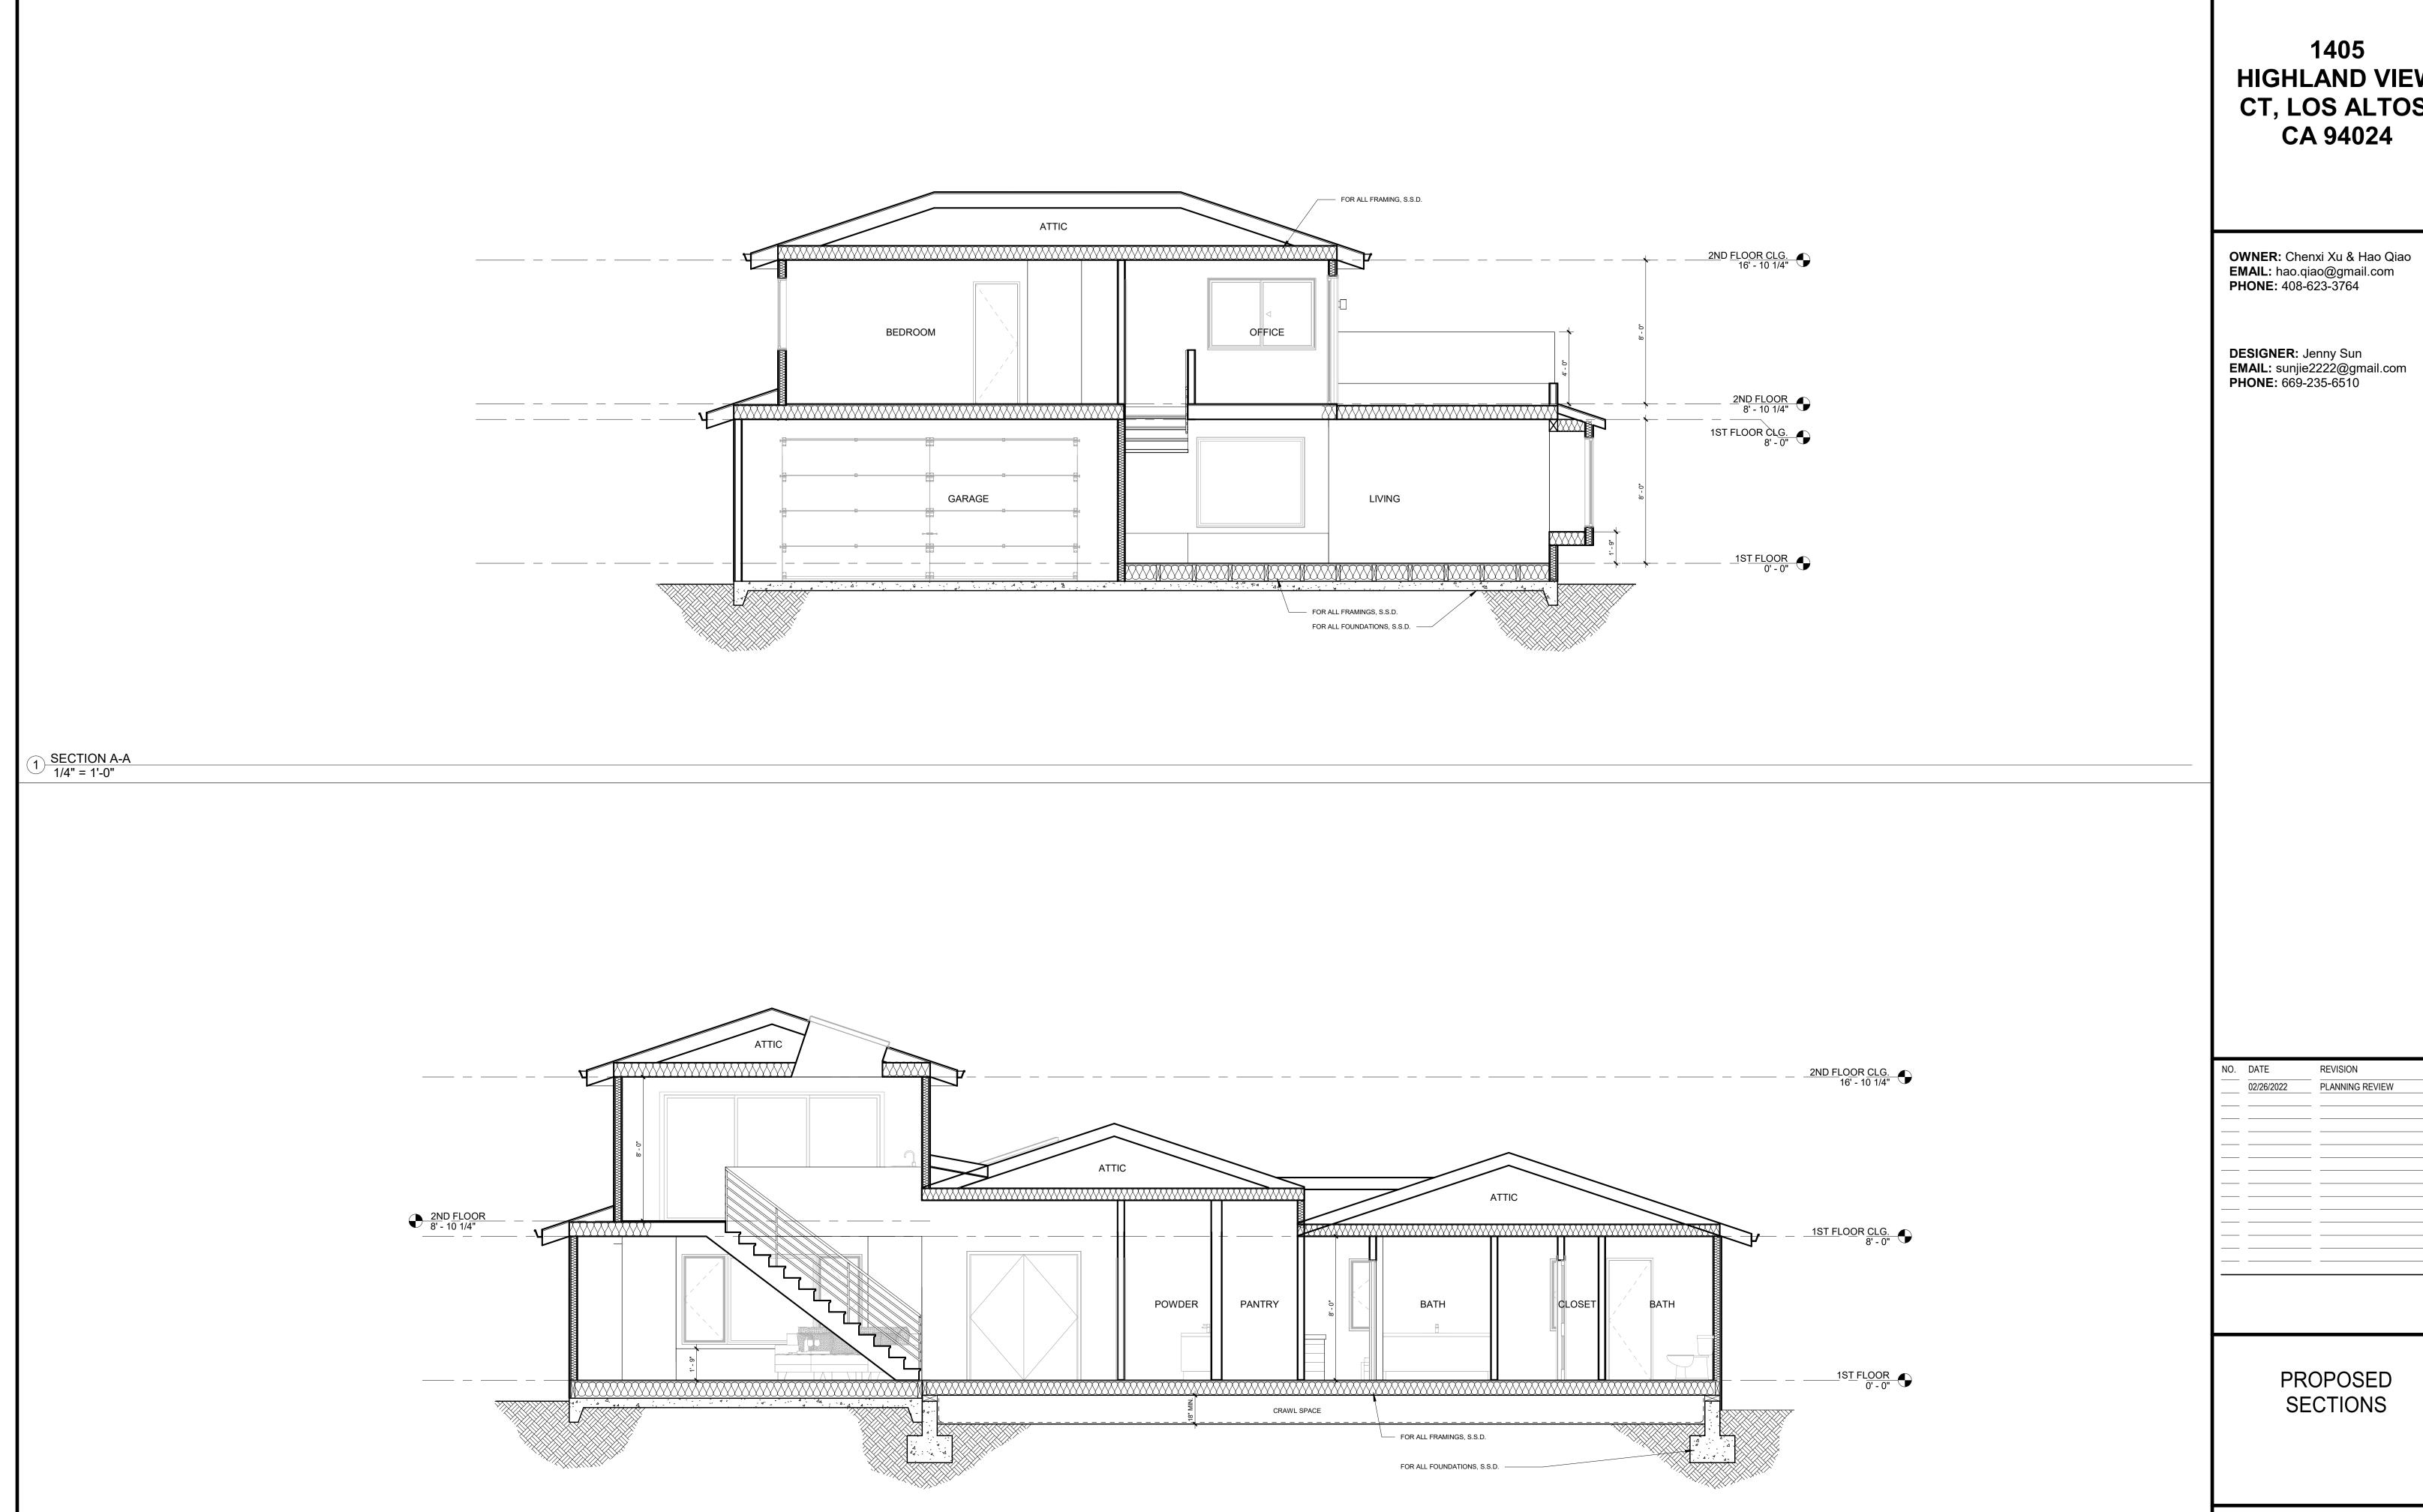2 SECTION B-B 1/4" = 1'-0"

**HIGHLAND VIEW** CT, LOS ALTOS, CA 94024

SHEET NUMBER

